



REQUEST FOR QUOTATION

Infrastructure

(Negotiated Procurement-Small Value Procurement)

The City Government of Naga (CGN), through its Bids and Awards Committee (BAC), hereby invites all interested contractors, to quote their lowest price on the project stated below, subject to the Terms of Reference (TOR) and submit the same duly signed by their authorized representative not later than 3:00PM on Monday, November 4, 2024, at the City Procurement Office, City Hall Compound, J. Miranda Avenue, Naga City. Opening of sealed bids will be at 3:00PM on the same day.

Name of Project and Location:	NCGH DIALYSIS CENTER, Naga City General Hospital, Bgy. Balatas, Naga City
Contract Reference Number:	009639-2024-01
Approved Budget for the Contract:	P 986,800.00

TERMS OF REFERENCE

I. The following documentary requirements shall be submitted together with the price quotation (**sealed in an envelope**):

1. PhilGEPS Registration Certificate-Platinum (Attach Annex "A" stating that you have a current and updated file of the following Class "A" eligibility documents under Section 23.1(a) and 24.1):
 - a. SEC/DTI/CDA Registration Certificate
 - b. Mayor's/Business Permit
 - c. Tax Clearance
 - d. Philippine Contractors Accreditation Board (PCAB) license and registration
 - e. Audited Financial Statements
2. BIR Registration Certificate
3. Income Tax Return (ITR)
4. Omnibus Sworn Statement
5. Affidavit of Site Inspection

II. Implementation Schedule:

The project should be completed within **twenty-one (21)** calendar days starting from receipt of Notice to Proceed (NTP).

III. General Conditions:

1. All quotations must be legibly written.
2. Price offers exceeding the Approved Budget for the Contract (ABC) shall be automatically disqualified.
3. Bid offers shall be duly supported by the bidder's detailed computation of estimated costs for each item.
4. Total bid offers shall be inclusive of taxes such as but not limited to VAT, income tax, local tax and other levies.
5. Price quotation will be valid for one hundred and twenty (120) calendar days from date of opening of sealed bids.
5. The price offered shall not be subject to any increase for whatever reason including in cases of devaluation/inflation during the entire duration of the contract.

IV. Award of Contract

The BAC shall recommend to the CGN the award of contract to the bidder with the Lowest Calculated Responsive Bid (LCRB).

V. Performance Security

1. To guarantee the faithful performance of the successful bidder of its obligation under the contract, it shall post a Performance Security within ten (10) calendar days from the receipt of Notice of Award (NOA), which shall answer for any liability arising from the performance of the contract.
2. The performance security shall be denominated in Philippine Pesos and posted in favor of the Procuring Entity in an amount not less than the percentage of the total contract price in accordance with the following schedule:

Form of Performance Security	Amount of Performance Security (Not less than the Percentage of the Total Contract Price)
Cash or cashier's/manager's check issued by a Universal or Commercial Bank. <i>(The Cashier's/Manager's Check may be issued by other banks certified by the BSP as authorized to issue such financial instrument.</i>	Ten percent (10%)
Bank draft/guarantee or irrevocable letter of credit issued by a Universal or Commercial Bank: Provided, however, that it shall be confirmed or authenticated by a Universal or Commercial Bank, if issued by a foreign bank. <i>(The Bank Draft/Guarantee, or Irrevocable Letter of Credit may be issued by other banks certified by the BSP as authorized to issue such financial instrument.</i>	
Surety bond callable upon demand issued by a surety or insurance company duly certified by the Insurance Commission as authorized to issue such security.	Thirty percent (30%)

3. The performance security posted in favor of the Procuring Entity shall be forfeited in the event it is established that the Contractor is in default in any of its obligations under the Contract.

VI. Contract Signing

1. The CGN shall enter into contract with the winning bidder upon posting of the required Performance Security and insurance coverage. The following documents shall form part of the contract:
 - a. Contract Agreement;
 - b. Terms of Reference;
 - c. Price Quotation Form including the detailed cost computation of estimated costs; and
 - d. Notice of Award

VII. Notice to Proceed (NTP)

The CGN shall issue the NTP to the successful bidder upon approval of the contract by the Head of the Procuring Entity.

VIII. Progress Payments:

1. The contractor may submit a request for payment for work accomplished. Such request for payment shall be verified and certified by the CGN's Project Engineer. Materials and equipment delivered on the site but not completely and properly installed shall not be included for payment.
2. The first progress payment may be paid by the CGN to the contractor provided that at least fifty percent (50%) of the work has been accomplished as certified by the CGN's Project Engineer.

IX. Warranty Security:

1. To guarantee that the contractor shall perform his responsibilities as prescribed in Section 62.2.3.1(a) of this IRR, it shall be required to post a warranty security in accordance with the following schedule:

Form of Warranty Security	Amount of Warranty Security (Not less than the required percentage of the Total Contract Price)
a. Cash or Letter of Credit issued by a Universal or Commercial Bank: Provided, however, That the Letter of Credit shall be confirmed or authenticated by a Universal or Commercial Bank, if issued by a foreign bank. (The Letter of Credit may be issued by other banks certified by the BSP as authorized to issue such financial instrument.)	Five percent (5%)
b) Bank guarantee confirmed by a Universal or Commercial Bank. (The bank draft/guarantee may be issued by other banks certified by the BSP as authorized to issue such financial instrument.)	Ten percent (10%)
c) Surety bond callable upon demand issued by GSIS or a surety or insurance company duly certified by the Insurance Commission as authorized to issue such security.	Thirty percent (30%)

2. The warranty security shall be denominated in Philippine Pesos, remain effective for one (1) year from the date of issuance of the Certificate of Final Acceptance by the CGN.

X. Liquidated Damages

The Contractor shall pay liquidated damages to the CGN at the rate per day of delay.


The applicable liquidated damages is at least one tenth (1/10) of one percent of the cost of the unperformed portion for every day of delay. Once the cumulative amount of liquidated damages reaches ten percent (10%) of the amount of this contract the CGN shall rescind this Contract, without prejudice to the other courses of action and remedies open to it.

For further inquiries, please coordinate with the BAC Secretariat at the address below:

BAC Secretariat/City Procurement Office
GF, Room 108, Main Building, City Hall Compound
J. Miranda Avenue, Concepcion Pequena, Naga City

The City Government of Naga reserves the right to reject any or all price quotations, to waive any minor defects therein, to annul the bidding process, to reject all price quotations, at any time prior to contract award, thereby incurring any liability to the affected bidder(s), and to accept only the offer that is most advantageous to the government.

The CGN assumes no responsibility whatsoever to compensate and indemnify bidders for any expenses incurred in the preparation of their price quotations.

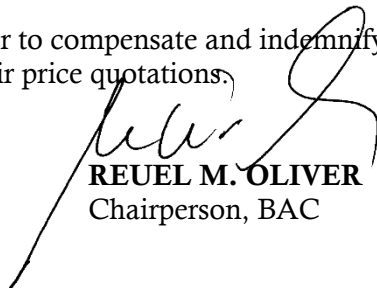

REUEL M. OLIVER
Chairperson, BAC

PRICE QUOTATION

TO: **Mr. FRANCISCO M. MENDOZA**
BAC Chairperson

Sir:

After having carefully read and accepted the Terms of Reference for the **PROPOSED NCGH DIALYSIS CENTER, BGY. BALATAS, NAGA CITY**, I hereby submit, **in a sealed envelope**, my price quotation, along with the required documents and detailed computation of estimated costs:

Item No.	Item Description/ Specifications/ Scope of Work	Quantity	Unit	Unit Cost	Total Cost
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PROPOSED NCGH DIALYSIS CENTER, BGY. BALATAS, NAGA CITY
Contract Reference Number: 009639-2024-01
Approved Budget for the Contract (ABC) – P 986,800.00

Equipment Required:	N/A				
Location:	Naga City General Hospital, Bgy. Balatas, Naga City				
Item I	Plumbing Works	1.00	Lot		
Item II	Sanitary Works	1.00	Lot		
Item III	Electrical Works	1.00	Lot		
Item VI	Aluminum Framed Glass Partitions	1.00	Lot		
Item VIII	Reprocessing Room Improvement	1.00	Lot		
T O T A L					

In words:

If our bid is accepted, we undertake to provide the required performance security.

We agree to abide by this bid for the bid validity period of one hundred twenty (120) days and it shall remain binding upon us and may be accepted at any time before the expiration of that period.

Until a formal contract is prepared and executed, this bid, together with your written acceptance thereof and your Notice of Award (NOA) shall be binding upon us.

We understand that you are not bound to accept the lowest or any bid you may receive.


Name of Firm/Offeror _____

Printed Name and
Signature of
Representative


Address _____

Tel. No./Mobile
No./Email Address _____

Date _____

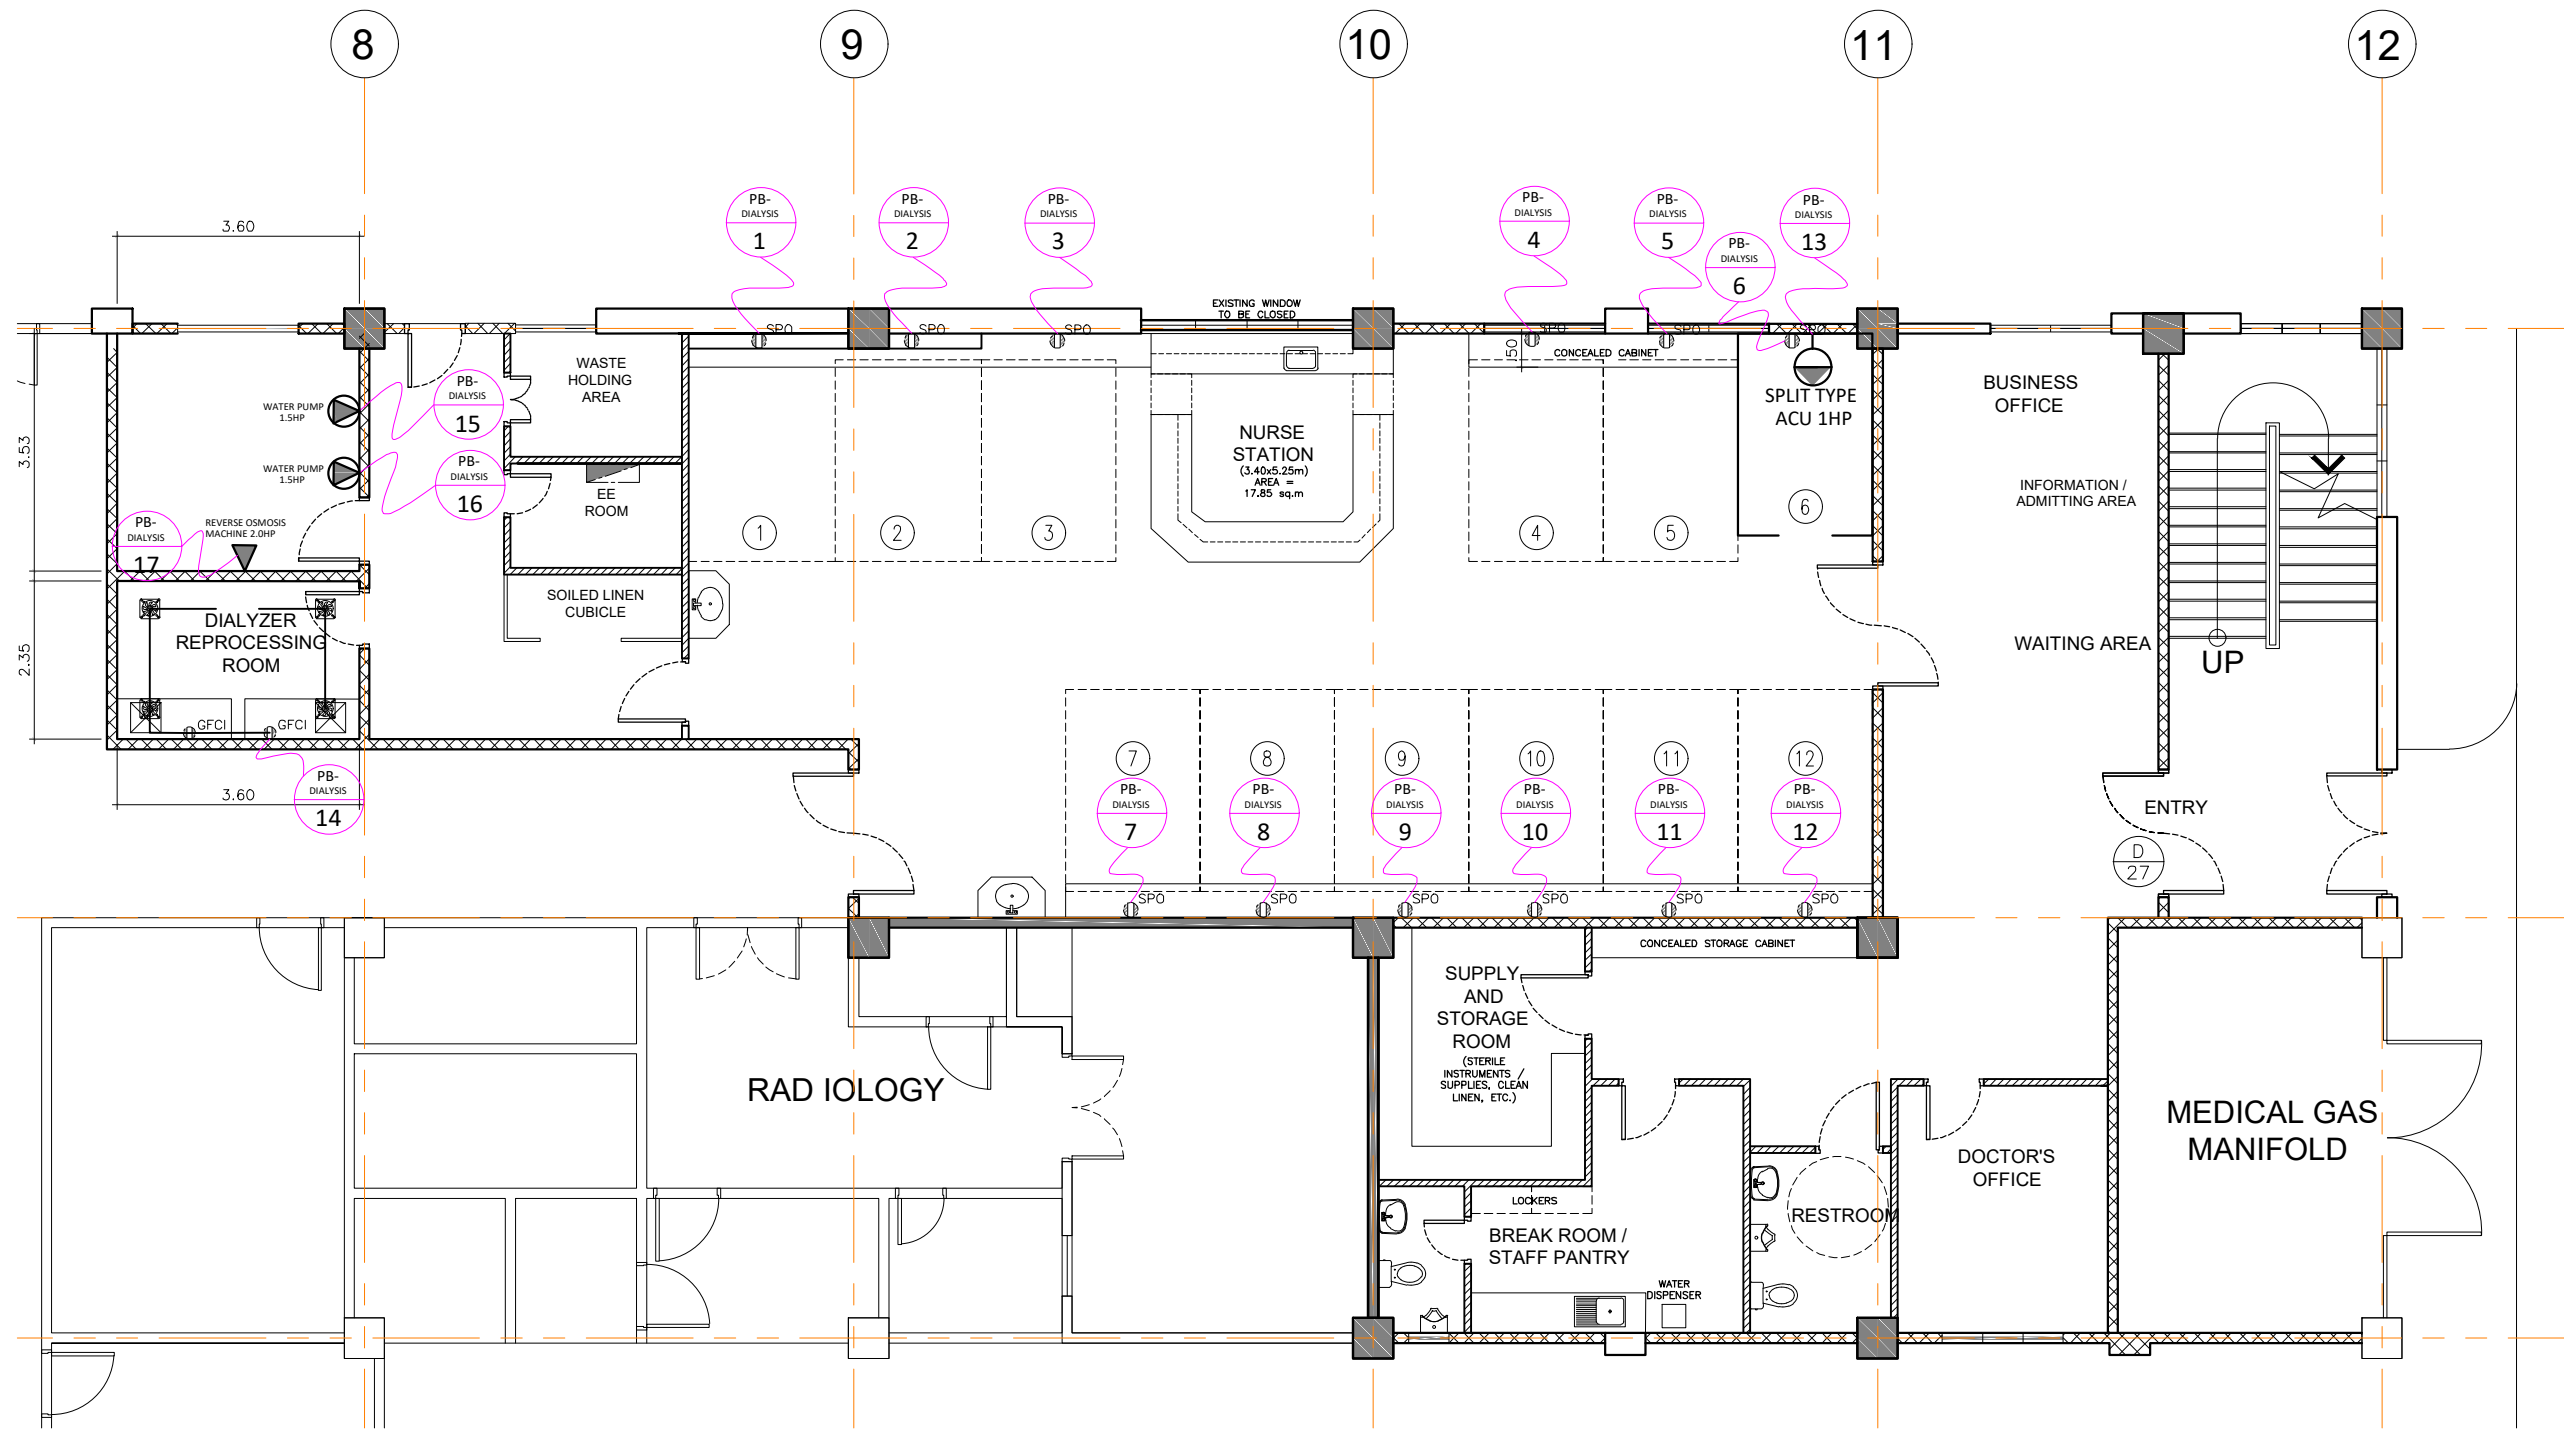

**GROUND FLOOR LEVEL (HEMO-DIALYSIS FLOOR PLAN)
POWER LAYOUT PLAN**

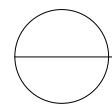

SCALE:

1:100M.



REPUBLIC OF THE PHILIPPINES
OFFICE OF THE CITY ENGINEER
CITY OF NAGA



PROJECT TITLE
PROPOSED NCGH DIALYSIS CENTER
LOCATION: NAGA CITY GENERAL HOSPITAL CMPND, BALATAS, N.C.

CERTIFIED BY
JENIFFER P. TOLARBA, ugp
ARCHITECT IV

CONCURRED BY
DR. JOSEPH SANCHEZ
MEDICAL CHIEF

RECOMMENDED BY
EMMEL M. ADAQUE
ACTING CITY ENGINEER

APPROVED BY
ALEXANDER N. CANING
ACTING CITY ENGINEER


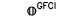



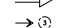






NELSON S. LEGACION
CITY MAYOR

SHEET NO.

SCHEDULE OF LOAD: PB-LAUNDRY																	
CKT. NO.	LOAD DESCRIPTION	NO.OF			SWITCHES				AMP.				V	VA	CB	SIZE OF WIRE	
		LO	CO	OTHERS	S1	S2	S3	S3W	AN	BN	CN	3Ø				WIRE	CONDUIT
1	DIALYSIS MACHINE POWER OUTLET			1					9.0				230	2,070	20,1P	2C-3.5MM2 THHN/THWN WIRE-2 1C-3.5MM2 THHN/THWN WIRE	20MMØ UPVC PIPE
2	DIALYSIS MACHINE POWER OUTLET			1					9.0				230	2,070	20,1P	2C-3.5MM2 THHN/THWN WIRE-2 1C-3.5MM2 THHN/THWN WIRE	20MMØ UPVC PIPE
3	DIALYSIS MACHINE POWER OUTLET			1					9.0				230	2,070	20,1P	2C-3.5MM2 THHN/THWN WIRE-2 1C-3.5MM2 THHN/THWN WIRE	20MMØ UPVC PIPE
4	DIALYSIS MACHINE POWER OUTLET			1					9.0				230	2,070	20,1P	2C-3.5MM2 THHN/THWN WIRE-2 1C-3.5MM2 THHN/THWN WIRE	20MMØ UPVC PIPE
5	DIALYSIS MACHINE POWER OUTLET			1					9.0				230	2,070	20,1P	2C-3.5MM2 THHN/THWN WIRE-2 1C-3.5MM2 THHN/THWN WIRE	20MMØ UPVC PIPE
6	DIALYSIS MACHINE POWER OUTLET			1					9.0				230	2,070	20,1P	2C-3.5MM2 THHN/THWN WIRE-2 1C-3.5MM2 THHN/THWN WIRE	20MMØ UPVC PIPE
7	DIALYSIS MACHINE POWER OUTLET			1					9.0				230	2,070	20,1P	2C-3.5MM2 THHN/THWN WIRE-2 1C-3.5MM2 THHN/THWN WIRE	20MMØ UPVC PIPE
8	DIALYSIS MACHINE POWER OUTLET			1					9.0				230	2,070	20,1P	2C-3.5MM2 THHN/THWN WIRE-2 1C-3.5MM2 THHN/THWN WIRE	20MMØ UPVC PIPE
9	DIALYSIS MACHINE POWER OUTLET			1					9.0				230	2,070	20,1P	2C-3.5MM2 THHN/THWN WIRE-2 1C-3.5MM2 THHN/THWN WIRE	20MMØ UPVC PIPE
10	DIALYSIS MACHINE POWER OUTLET			1					9.0				230	2,070	20,1P	2C-3.5MM2 THHN/THWN WIRE-2 1C-3.5MM2 THHN/THWN WIRE	20MMØ UPVC PIPE
11	DIALYSIS MACHINE POWER OUTLET			1					9.0				230	2,070	20,1P	2C-3.5MM2 THHN/THWN WIRE-2 1C-3.5MM2 THHN/THWN WIRE	20MMØ UPVC PIPE
12	DIALYSIS MACHINE POWER OUTLET			1					9.0				230	2,070	20,1P	2C-3.5MM2 THHN/THWN WIRE-2 1C-3.5MM2 THHN/THWN WIRE	20MMØ UPVC PIPE
13	1.0 HP ACU SPLIT TYPE			1					8.0				230	1,840	30,1P	2C-5.5MM2 THHN/THWN WIRE-2 1C-5.5MM2 THHN/THWN WIRE	20MMØ UPVC PIPE
14	EXHAUST FAN POWER OUTLET		2	4					4.69				230	1,080	20,1P RCBO	2C-3.5MM2 THHN/THWN WIRE-2 1C-3.5MM2 THHN/THWN WIRE	20MMØ UPVC PIPE
15	1.5 HP WATER PUMP			1					12.0				230	2,760	30,1P	2C-5.5MM2 THHN/THWN WIRE-2 1C-5.5MM2 THHN/THWN WIRE	20MMØ UPVC PIPE
16	1.5 HP WATER PUMP			1					12.0				230	2,760	30,1P	2C-5.5MM2 THHN/THWN WIRE-2 1C-5.5MM2 THHN/THWN WIRE	20MMØ UPVC PIPE
17	2.0 HP REVERSED OSMOSIS MACHINE			1					16.0				230	3,680	30,1P	2C-5.5MM2 THHN/THWN WIRE-2 1C-5.5MM2 THHN/THWN WIRE	20MMØ UPVC PIPE
18	S P A R E								12.0				230	2,760			
19	S P A R E								12.0				230	2,760			
20	S P A R E								12.0				230	2,760			
T O T A L									72.69	60.00	64.00	74.49	400	45,240	100AT,3P	4C-30.0MM2 THHN/THWN WIRE-2 1C-8.0MM2 THHN/THWN WIRE	50MMØ UPVC PIPE

USE : 100AT , 3P, MCCB, 400V
4C-30.0MM2 THHN/THWN WIRE-2
1C-8.0MM2 THHN/THWN WIRE

LEGEND:

-  SPECIAL POWER OUTLET FOR DIALYSIS MACHINE
-  GFCI OUTLET
-  EXHAUST FAN
-  ACU
-  WATER PUMP
-  REVERSED OSMOSIS MACHINE
-  Service Entrance
-  Circuit Homerun
-  Panelboard
-  KWH Meter
-  Circuit Breaker with Rating
-  Ground

SPECIFICATION:

- ALL INSTALLATION SHALL BE IN COMPLIANCE TO P.E.C AND LOCAL ORDINANCES.
- ALL INTERIOR CONDUITS SHALL BE PNS 14.
- ALL CONDUITS ENTERING JUNCTION BOXES, PULL BOXES, AUXILLIARY GUTTER, PANEL BOARDS AND OTHER METAL BOXES SHALL BE TERMINATED IN APPROVED TYPE ADAPTORS.
- ALL LIGHTING FIXTURES SHALL BE GROUNDED AS REQUIRED BY ARTICLE 4.10 OF P.E.C. USE ADDITIONAL INSULATORS FOR TERMINATION AS NECESSARY.
- ALL JUNCTION AND UTILITY BOXES SHALL BE METAL GAUGE 16, HOT DIP GALVANIZED.
- CLEARANCES OF TERMINAL FROM ALL METAL PARTS SHALL BE OBTAINED.
- BENDING RADIUS OF CONDUCTOR SHALL BE COMPLIANT TO P.E.C
- DERATING OF CONDUCTOR SHALL BE APPLIED FOR MORE THAN FOUR (4) CONDUCTORS IN CONDUITS OR WIRE WAYS.
- ALL INSTALLATIONS SHALL BE UNDER SUPERVISION OF LICENSE ELECTRICAL PRACTITIONERS.
- PANEL BOXES AND AUXILLIARY GUTTERS SHALL BE MADE OF 1.5mm G.I POWDER COATED OR ENAMEL FINISHED OVER APPROVED METAL PRIMER.
- ALL GROUNDING CONDUCTOR, GROUNDING ROD, SHALL BE BONDED TOGETHER.
- ALL EMERGENCY LIGHT CLEARANCE ALLOWANCE IS 0.30m FROM CEILING


TAP TO 100AT CHANGE THE 250AT SPARE LOCATED AT THE MDP EE ROOM GROUND FLOOR

NOTE:

20 AT - 1/4" X 1/8" BUSBAR SIZE

30 AT - 1/4" X 1/8" BUSBAR SIZE

1/2" X 1/4" BUSBAR SIZE

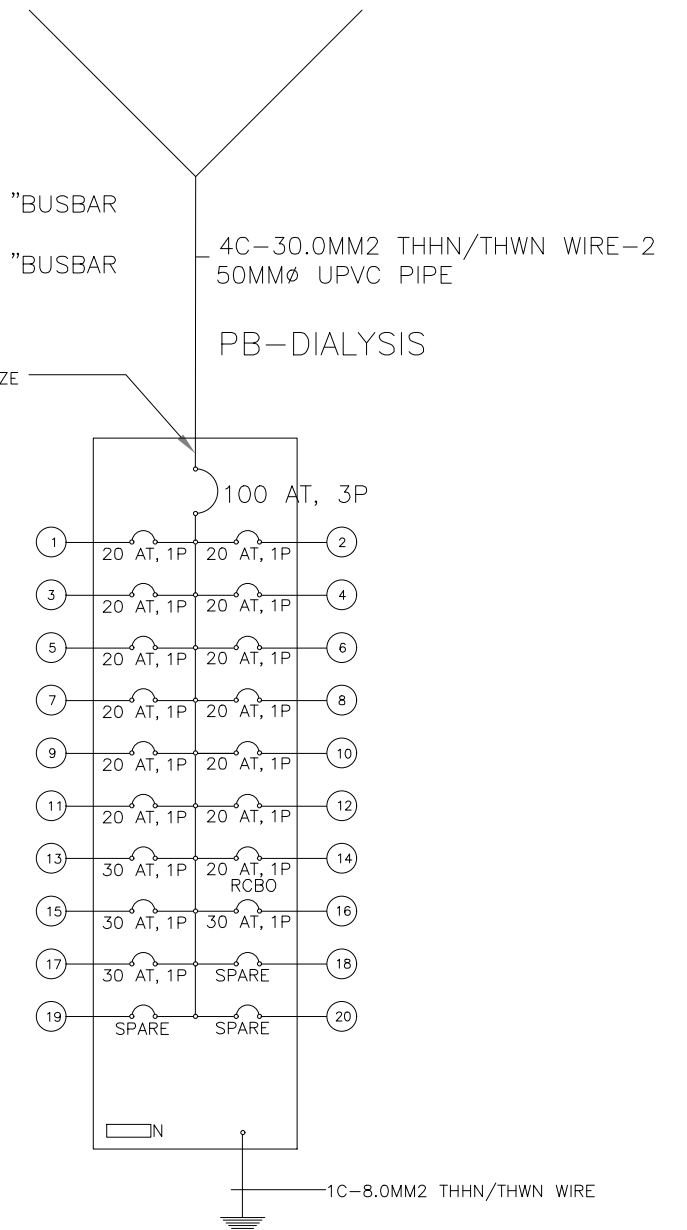

REPUBLIC OF THE PHILIPPINES
OFFICE OF THE CITY ENGINEER
CITY OF NAGA



PROJECT TITLE
PROPOSED NCGH DIALYSIS CENTER
LOCATION: NAGA CITY GENERAL HOSPITAL CMPND, BALATAS, N.C.

CERTIFIED BY
JENIFFER P. TOLARBA, ugp
ARCHITECT IV


CONCURRED BY
DR. JOSEPH SANCHEZ
MEDICAL CHIEF


RECOMMENDED BY
EMMEL M. ADAQUE
ACTING CITY ENGINEER


APPROVED BY
ALEXANDER N. CANING
ACTING CITY ENGINEER

NELSON S. LEGACION
CITY MAYOR

SHEET NO.

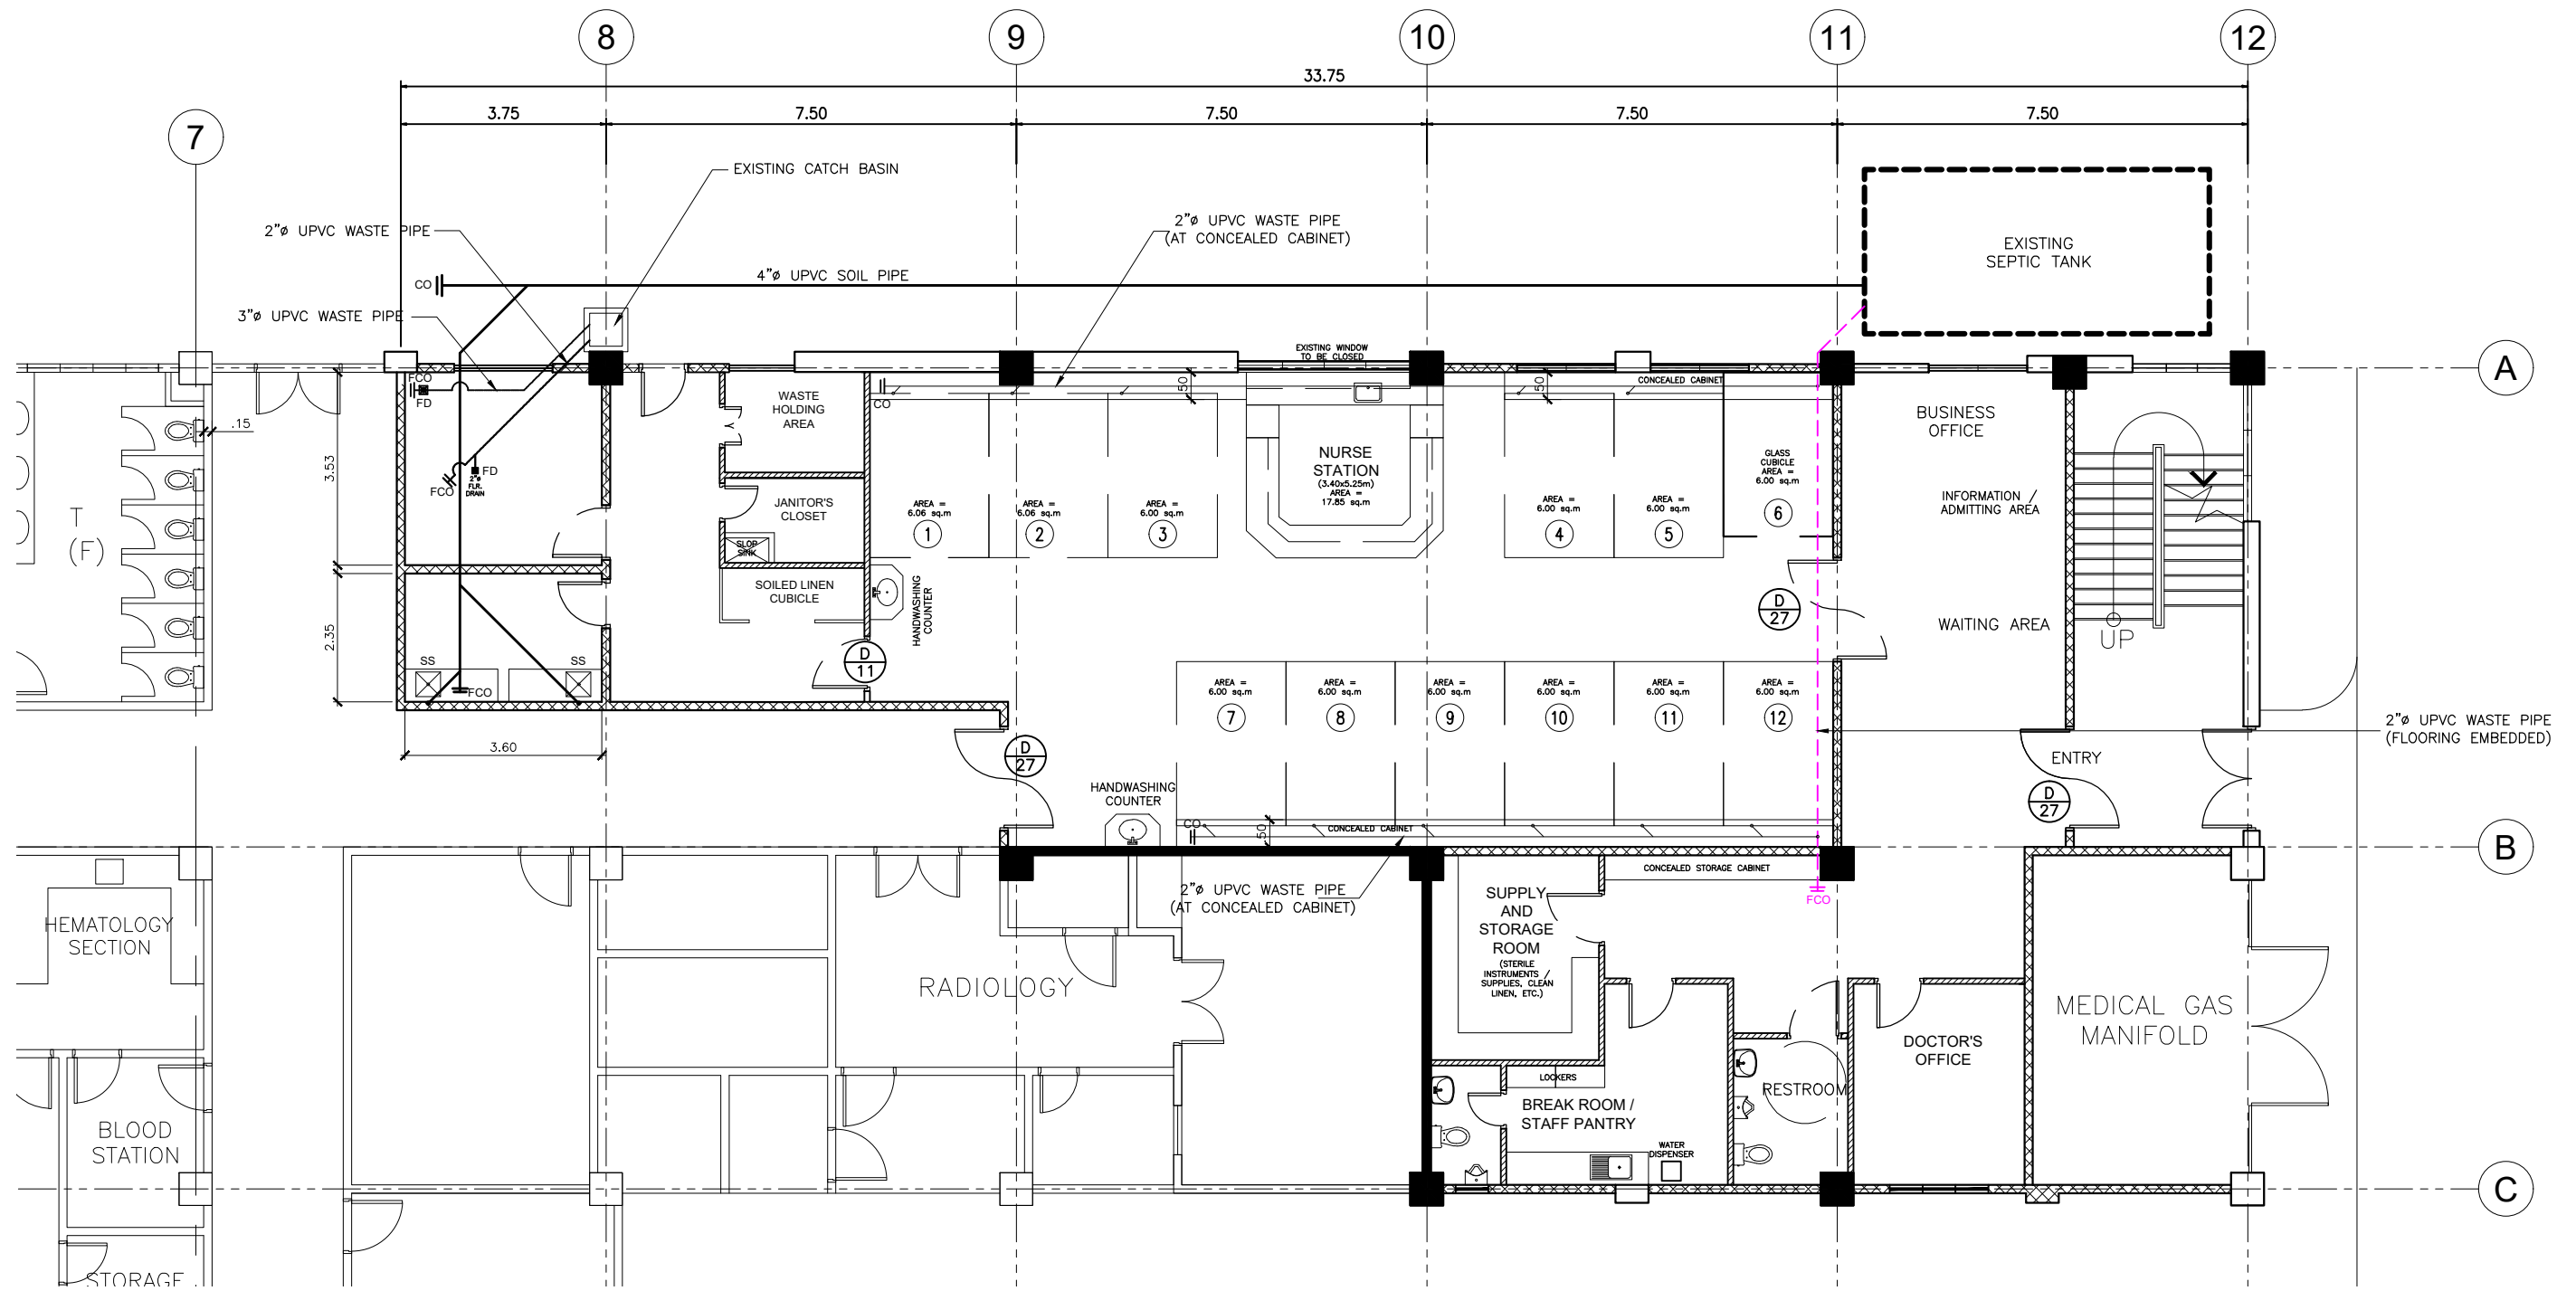

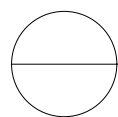
GROUND FLOOR LEVEL(DRAIN, WASTE & VENT LAYOUT)
 SCALE: 1:100M.

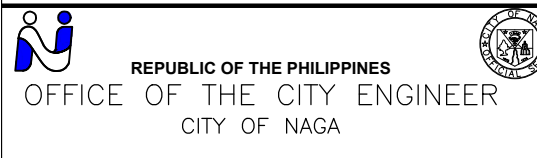	PROJECT TITLE	CERTIFIED BY	CONCURRED BY	RECOMMENDED BY	APPROVED BY	SHEET NO.
	PROPOSED NCGH DIALYSIS CENTER	JENIFFER P. TOLARBA, ugp ARCHITECT IV	DR. JOSEPH SANCHEZ MEDICAL CHIEF	EMMEL M. ADAQUE ACTING CITY ENGINEER	ALEXANDER N. CANING ACTING CITY ENGINEER	NELSON S. LEGACION CITY MAYOR
	LOCATION: NAGA CITY GENERAL HOSPITAL CMPND, BALATAS, N.C.					